


UPPER FLOOR 3D PLAN

SCALE: 1:200

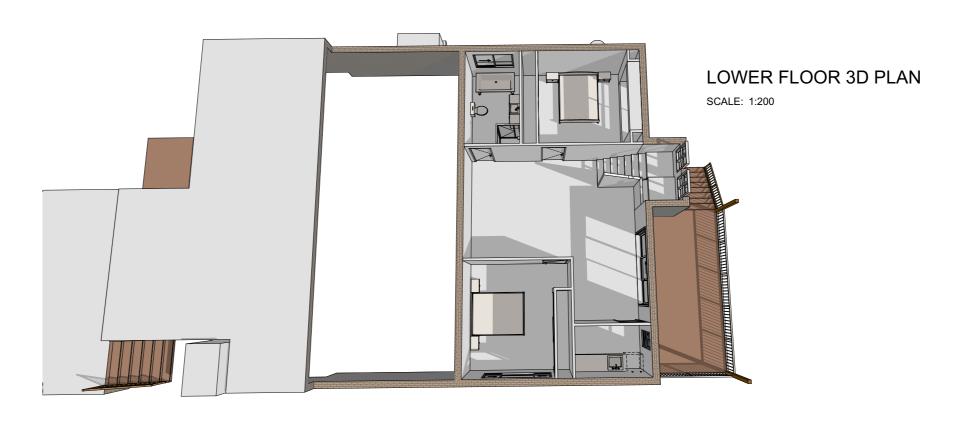

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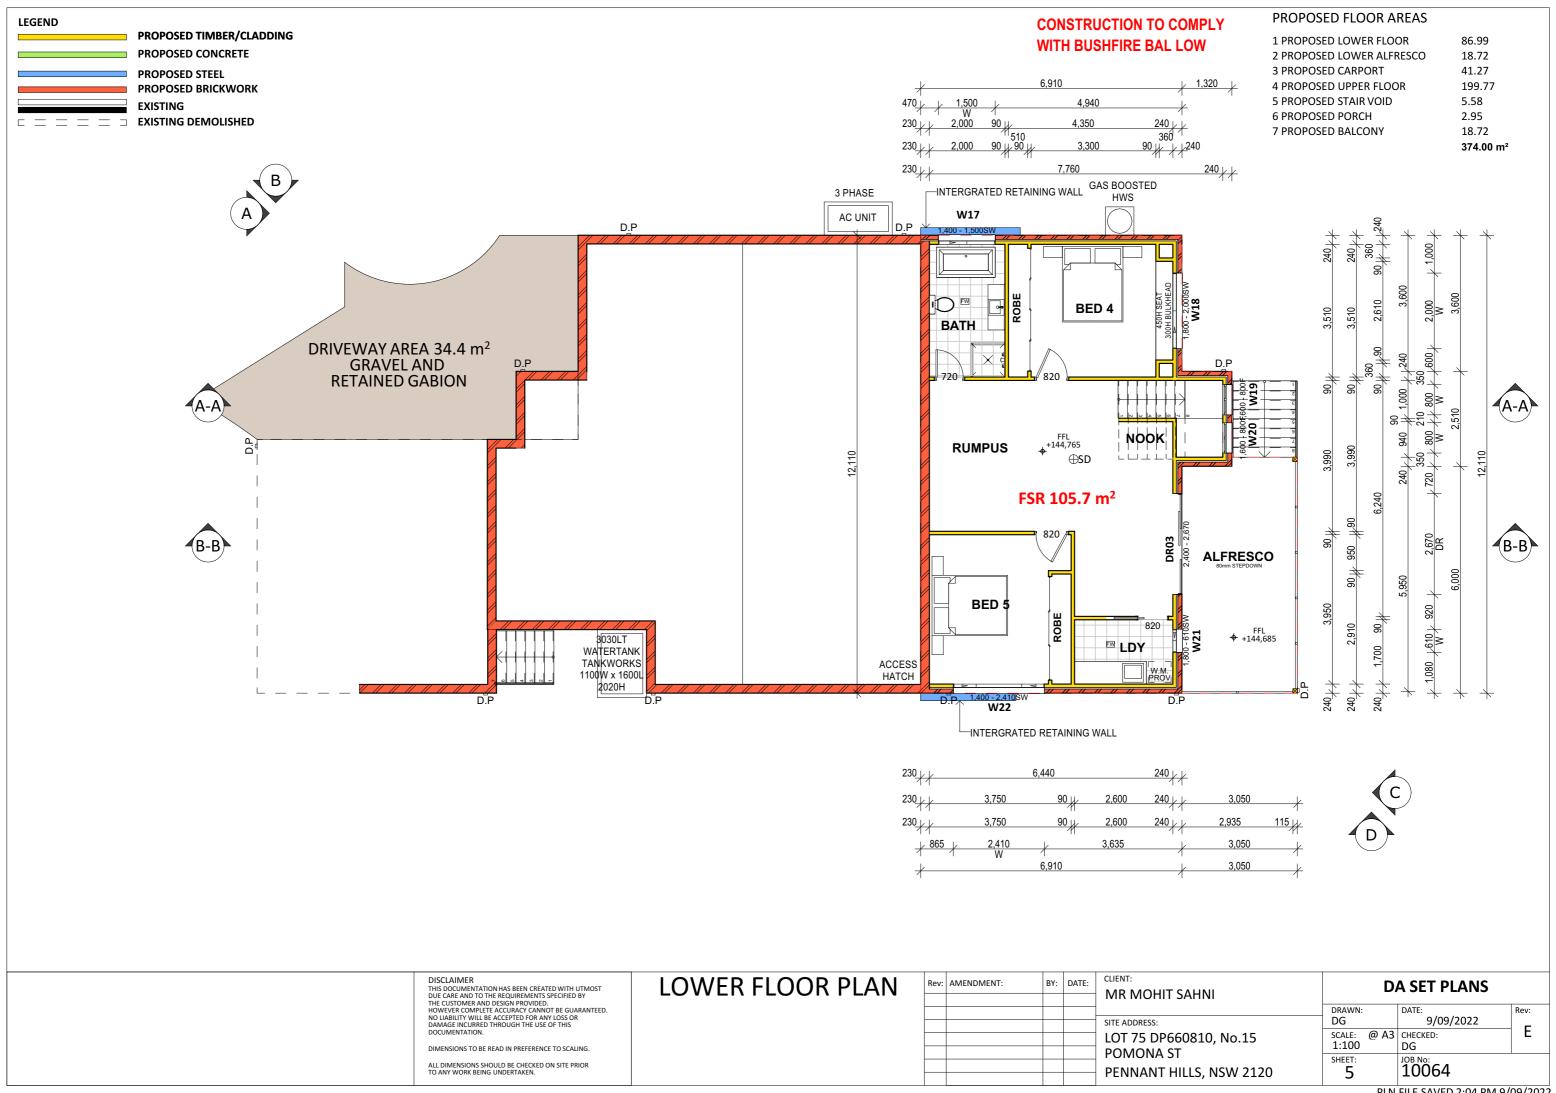
3D PLANS


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|------|------------|-----|-------|------------------------|
| | | | | MR MOHIT SAHNI |
| | | | | SITE ADDRESS: |
| | | | | LOT 75 DP660810, No.15 |
| | | | | POMONA ST |
| | | | | PENNANT HILLS, NSW 21 |


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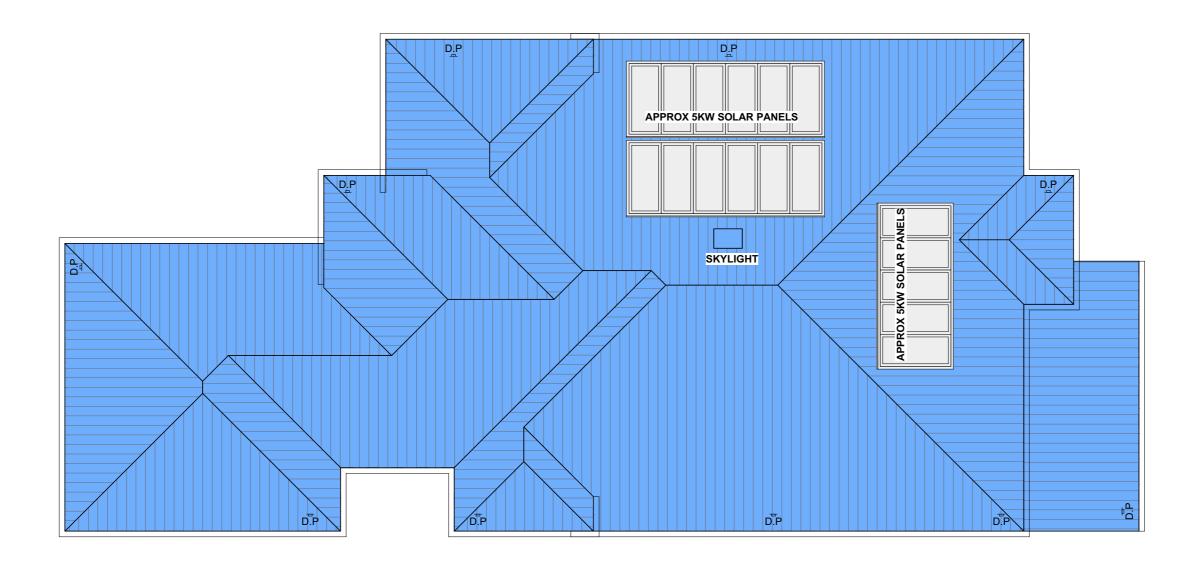
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| ENNANT HILLS, NSW 2120 | 4 | 10064 | |

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ROOF PLAN

SCALE: 1:100

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DOCUMENTATION. **ROOF PLAN** CLIENT: Rev: AMENDMENT: BY: DATE: MR MOHIT SAHNI SITE ADDRESS: LOT 75 DP660810, No.15 DIMENSIONS TO BE READ IN PREFERENCE TO SCALING. POMONA ST ALL DIMENSIONS SHOULD BE CHECKED ON SITE PRIOR TO ANY WORK BEING UNDERTAKEN.

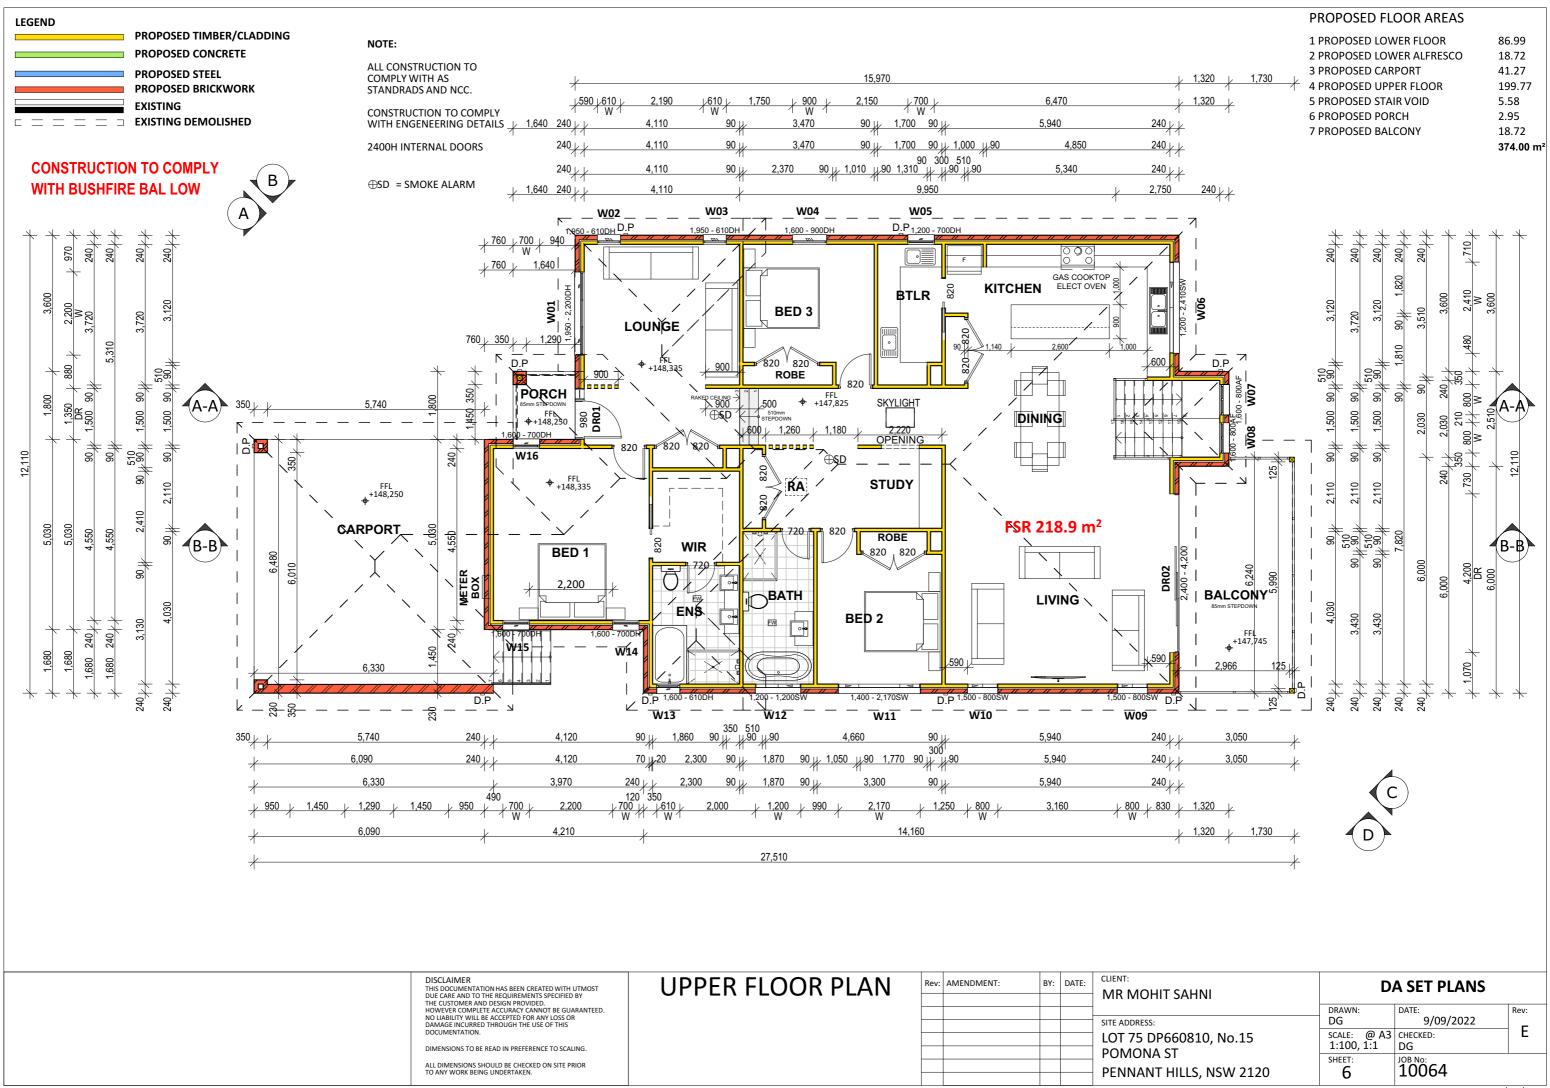9/09/2022
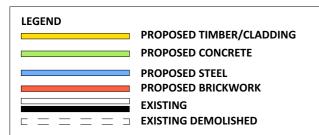
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DA SET PLANS


JOB No: 10064


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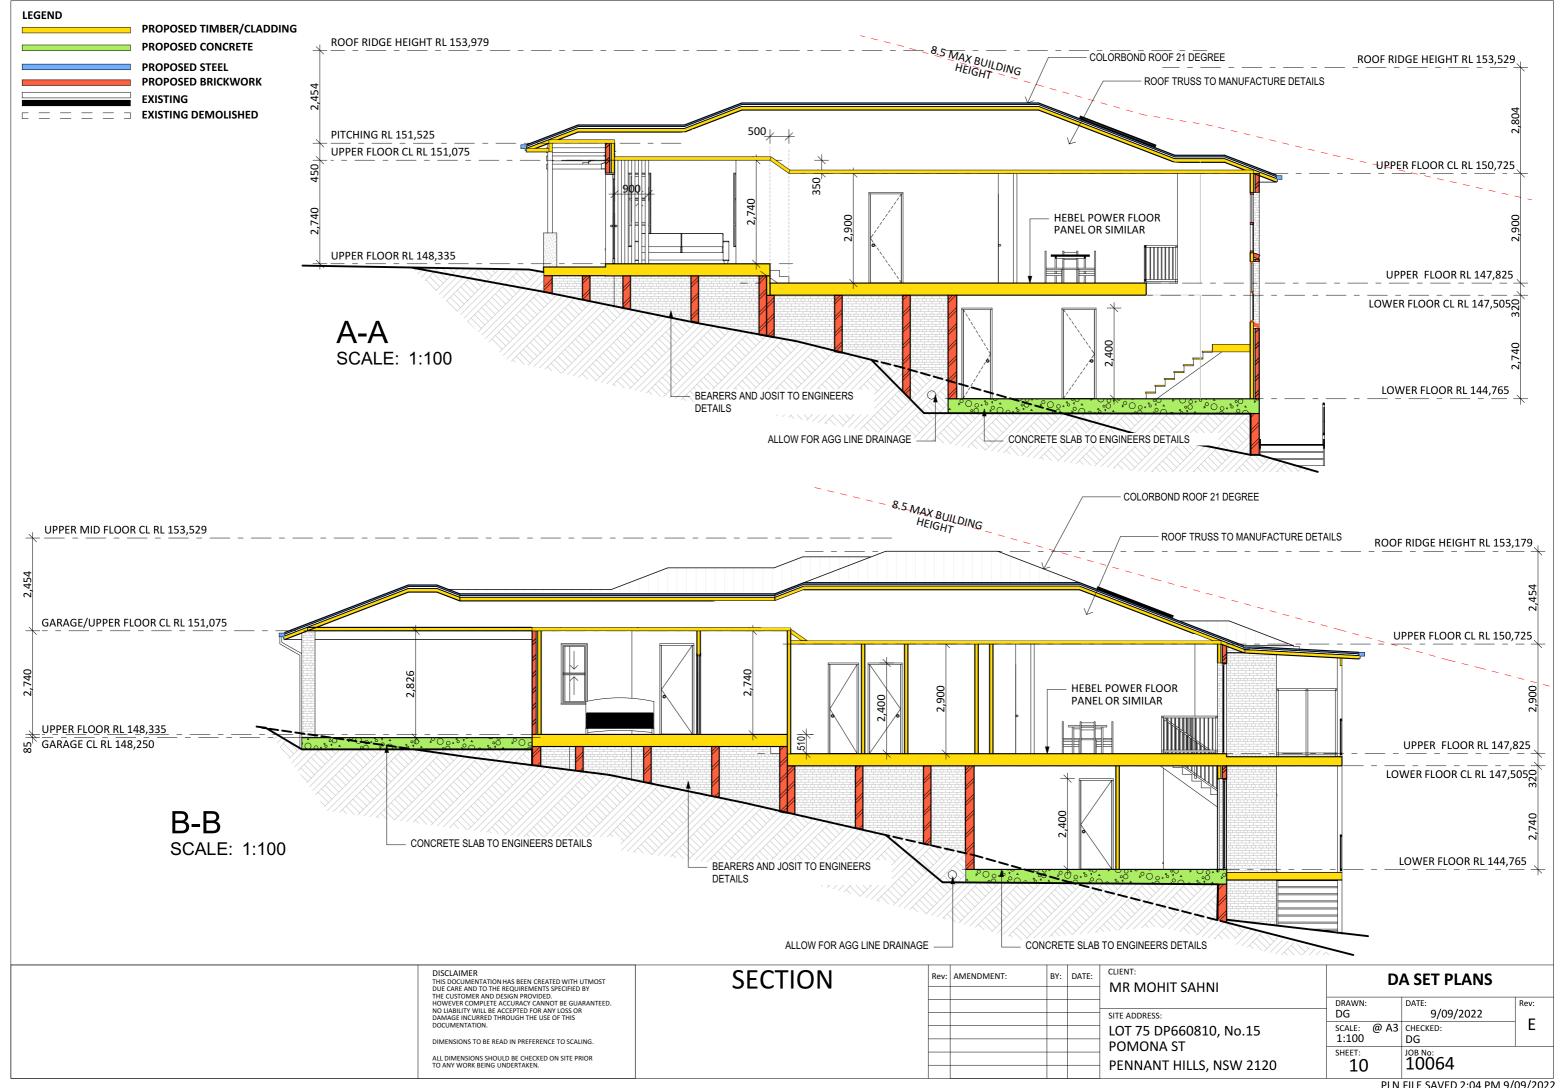
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PENNANT HILLS, NSW 2120

SCALE: @ A3 CHECKED: DG







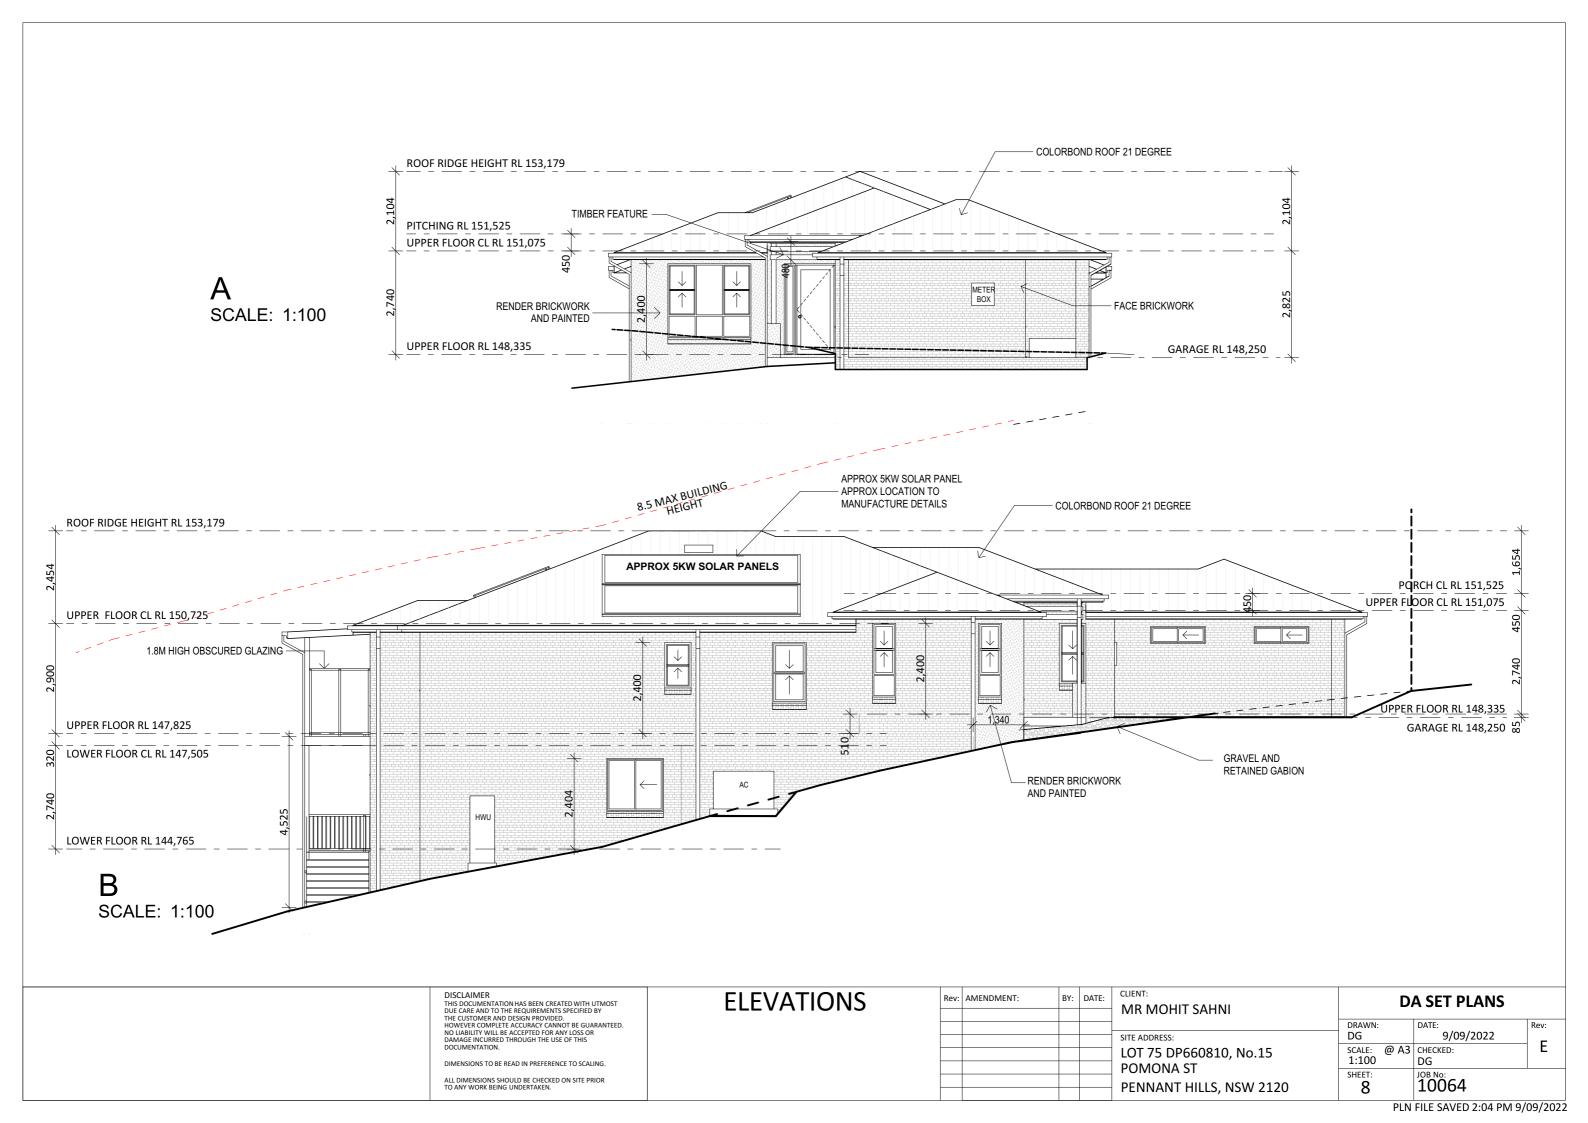
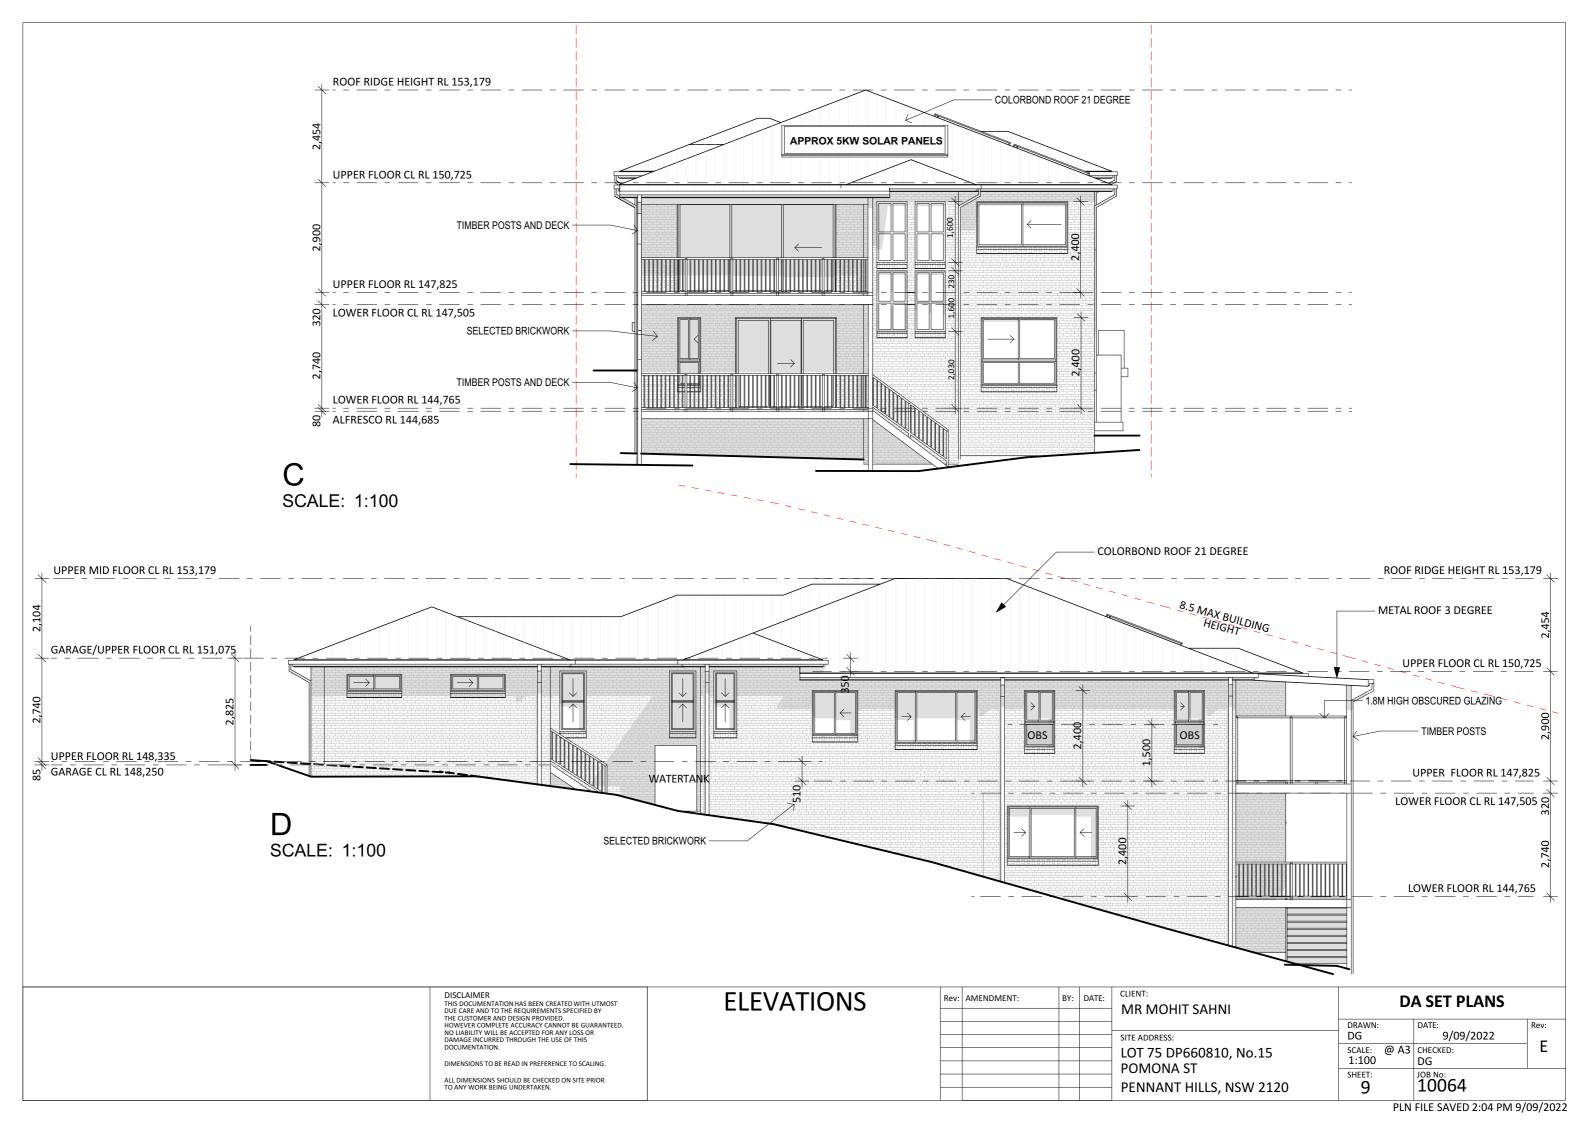
| WINDOW/DOOR LIS | ST . | | | | | | | | | | | | |
|-----------------|-------|----------|--|-------|-------|-------|-------|----------|-------|-------|-------|-------------|-------------|
| WINDOW/ DOOR | DR01 | DR02 | DR03 | W01 | W02 | W03 | W04 | W05 | W06 | W07 | W08 | W09 | W10 |
| ELEVATION | | <u>←</u> | $\begin{array}{ c c c c c c c c c c c c c c c c c c c$ | | | | | ↓ | low E | | | > | > |
| WIDTH | 980 | 4,200 | 2,670 | 2,200 | 610 | 610 | 900 | 700 | 2,410 | 800 | 800 | 800 | 800 |
| HEIGHT | 2,400 | 2,400 | 2,400 | 1,950 | 1,950 | 1,950 | 1,600 | 1,200 | 1,200 | 1,600 | 1,600 | 1,500 | 1,500 |
| AREA | 2.35 | 10.08 | 6.41 | 4.29 | 1.19 | 1.19 | 1.44 | 0.84 | 2.89 | 1.28 | 1.28 | 1.20 | 1.20 |

| WINDOW/DOOR LIS | ST | | | | | | | | | | | | | |
|-----------------|------------|-------|-------|-------|-------|-------|-------|-------|-------|-------|-------|--|-------|-------|
| WINDOW/ DOOR | W11 | W12 | W13 | W14 | W15 | W16 | W17 | W18 | W19 | W20 | W21 | W22 | W23 | W24 |
| ELEVATION | → ← | | | | | | | low E | | | | $ \longrightarrow \hspace{1cm} \longleftarrow$ | | |
| WIDTH | 2,170 | 1,200 | 610 | 700 | 700 | 700 | 1,500 | 2,000 | 800 | 800 | 610 | 2,410 | 1,450 | 1,450 |
| HEIGHT | 1,400 | 1,200 | 1,600 | 1,600 | 1,600 | 1,600 | 1,400 | 1,800 | 1,600 | 1,600 | 1,800 | 1,400 | 450 | 450 |
| AREA | 3.04 | 1.44 | 0.98 | 1.12 | 1.12 | 1.12 | 2.10 | 3.60 | 1.28 | 1.28 | 1.10 | 3.37 | 0.65 | 0.65 |

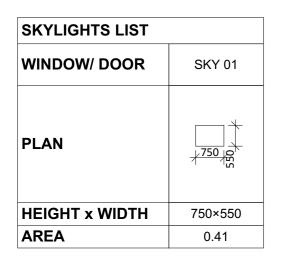

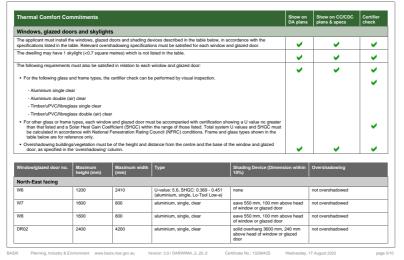

| Window/glazed door no. | Maximum height (mm) | Maximum width (mm) | Туре | Shading Device (Dimension within 10%) | Overshadowing |
|------------------------|------------------------|--------------------|---|--|------------------------|
| W18 | 1900 | 2400 | U-value: 5.6, SHGC: 0.369 - 0.451 (aluminium, single, Lo-Tsol Low-e) | eave 550 mm, 520 mm above head of window or glazed door | not overshadowed |
| W19 | 1600 | 800 | aluminium, single, clear | eave 550 mm, 1700 mm above head of window or glazed door | not overshadowed |
| W20 | 1600 | 800 | aluminium, single, clear | eave 550 mm, 1700 mm above head of window or glazed door | not overshadowed |
| W21 | 1800 | 610 | aluminium, single, clear | solid overhang 3050 mm, 240 mm above head of window or glazed door | not overshadowed |
| DR03 | 2400 | 2670 | aluminium, single, clear | solid overhang 3050 mm, 240 mm above head of window or glazed door | not overshadowed |
| South-East facing | | | | | |
| W9 | 1500 | 800 | aluminium, single, clear | eave 550 mm, 570 mm above head of window or glazed door | >4 m high, 2-5 m away |
| W10 | 1500 | 800 | aluminium, single, clear | eave 550 mm, 570 mm above head of window or glazed door | >4 m high, 2-5 m away |
| W11 | 1400 | 2170 | aluminium, single, clear | eave 550 mm, 570 mm above head of window or glazed door | >4 m high, 2-5 m away |
| W12 | 1200 | 1200 | aluminium, single, clear | eave 550 mm, 570 mm above head of window or glazed door | >4 m high, 2-5 m away |
| W13 | 1600 | 610 | aluminium, single, clear | eave 550 mm, 100 mm above head of window or glazed door | >4 m high, 2-5 m away |
| W14 | 1600 | 610 | aluminium, single, clear | eave 550 mm, 100 mm above head of window or glazed door | >4 m high, 2-5 m away |
| W15 | 1600 | 700 | aluminium, single, clear | eave 550 mm, 100 mm above head of window or glazed door | >4 m high, 2-5 m away |
| W22 | 1400 | 2410 | aluminium, single, clear | none | >4 m high, 2-5 m away |
| South-West facing | | | | | |
| W24 | 1950 | 2200 | aluminium, single, clear | eave 550 mm, 100 mm above head of window or glazed door | 2-4 m high, 2-5 m away |
| North-West facing | | | | | |

| Vindow/glazed door no. | Maximum height (mm) | Maximum width (mm) | Туре | Shading Device (Dimension within 10%) | Overshadowing |
|------------------------|------------------------|--------------------|--------------------------|--|------------------------|
| W16 | 1600 | 700 | aluminium, single, clear | eave 550 mm, 100 mm above head of window or glazed door | 2-4 m high, 5-8 m away |
| W2 | 1950 | 610 | aluminium, single, clear | eave 550 mm, 100 mm above head of window or glazed door | 2-4 m high, 5-8 m away |
| N3 | 1950 | 610 | aluminium, single, clear | eave 550 mm, 100 mm above head of window or glazed door | 2-4 m high, 5-8 m away |
| W4 | 1500 | 900 | aluminium, single, clear | eave 550 mm, 100 mm above head of window or glazed door | 2-4 m high, 5-8 m away |
| W5 | 1200 | 700 | aluminium, single, clear | eave 550 mm, 470 mm above head of window or glazed door | 2-4 m high, 5-8 m away |
| W17 | 1400 | 1500 | aluminium, single, clear | none | 2-4 m high, 5-8 m away |
| | | | | | |
| | | | | | |
| | | | | | |

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WINDOW/DOOR SCHEDULE

| ev: | AMENDMENT: | BY: | DATE: | CLIENT: |
|-----|------------|-----|-------|-------------------------|
| | | | | MR MOHIT SAHNI |
| | | | | SITE ADDRESS: |
| | | | | LOT 75 DP660810, No.15 |
| | | | | POMONA ST |
| | | | | PENNANT HILLS, NSW 2120 |

DA SET PLANS DRAWN: 9/09/2022 DG SCALE: @ A3 CHECKED: DG JOB No: 10064 11

BASIX*Certificate

Single Dwelling

Cartificate number: 12200426

This certificate confirms that the proposed development will meet the NSW government's requirements for sustainability, if it is built in accordance with the commitments set out below. Terms used in this certificate, or in the commitments, have the meaning given by the document entitled "BASIX Definitions" dated 10/09/2020 published by the Department. This document is available at www.basix.nsw.gov.au

Secretary
Date of issue: Wednesday, 17 August 2022
To be valid, this certificate must be lodged within 3 months of the date of issue.




| Project summary | | |
|---------------------------|---------------------|--------------------|
| Project name | 15 Pomona Street F | Pennant Hills 2120 |
| Street address | 15 Pomona Street F | Pennant Hills 2120 |
| Local Government Area | Homsby Shire Cour | ncil |
| Plan type and plan number | deposited 660810 | |
| Lot no. | 75 | |
| Section no. | - | |
| Project type | separate dwelling h | ouse |
| No. of bedrooms | 5 | |
| Project score | | |
| Water | ✓ 41 | Target 40 |
| Thermal Comfort | ✓ Pass | Target Pass |
| Energy | ✓ 53 | Target 50 |
| | | |

| Certificate Prepared by |
|--|
| Name / Company Name: Paul & C associates |
| ABN (if applicable): 26634614848 |
| |

| | | | plans | | _ |
|--|--|---------------|-----------|------------------------|----------|
| General features | | | | | |
| The dwelling must not have more than 2 storeys. | | | • | _ | . |
| The conditioned floor area of the dwelling must not exceed 3 | 00 square metres. | | _ | ~ | v |
| The dwelling must not contain open mezzanine area exceed | ng 25 square metres. | | _ | _ | v |
| The dwelling must not contain third level habitable attic room | - | | _ | _ | |
| Floor, walls and ceiling/roof | | | | | |
| The applicant must construct the floor(s), walls, and ceiling/repelow. | of of the dwelling in accordance with the specifications listed in the t | able | <u> </u> | ~ | |
| | , | | | | |
| Construction | Additional insulation required (R-Value) | her specific | ations | | |
| loor - concrete slab on ground, 72 square metres | nil | | | | |
| loor - suspended floor above enclosed subfloor, 114.5 square metres, framed | 1.10 (or 1.8 including construction) (down) | | | | |
| loor - above habitable rooms or mezzanine, 66 square netres, framed | nil | | | | |
| external wall - brick veneer | 1.86 (or 2.40 including construction) | | | | |
| ceiling and roof - flat ceiling / pitched roof | ceiling: 2.95 (up), roof: foil backed blanket (55 mm) un | ventilated; m | nedium (s | olar absorptance 0.475 | -0.70) |
| Note • Insulation specified in this Certificate must be insta | lled in accordance with Part 3.12.1.1 of the Building Code of Australia | э. | | | |
| Note • In some climate zones insulation should be installed | ed with due consideration of condensation and associated interaction | | | | |

| Of window or glazed door W2 1950 610 aluminium, single, clear eave \$50 mm, 100 mm above head 2-4 exection eave \$50 mm, 100 mm above head 2-4 exection ex | 4 m high, 5-8 m away |
|--|----------------------|
| Of window or glazed door 1950 610 aluminium, single, clear eave 550 mm, 100 mm above head 2-4 24 25 25 25 25 25 25 2 | 4 m high, 5-8 m away |
| | |
| | 4 m high, 5-8 m away |
| W5 1200 700 aluminium, single, clear eave 550 mgs, 2470 mg above head 24 of window or glazzed door | 4 m high, 5-8 m away |
| of window or glazed door | 4 m high, 5-8 m away |
| W17 1400 1500 aluminium, single, clear none 2-4 | 4 m high, 5-8 m away |
| | 4 m high, 5-8 m away |
| | |
| | |
| SIX Planning, Industry & Environment www.basix.nsw.gov.au Version: 3.0 / DARWINIA_3_20_0 Certificate No.: 1329942S Wednesday, 17 Au | |

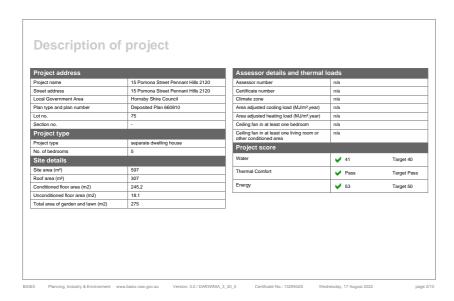

| Thermal Comfort Co | mmitments | | | | Show on DA plans | Show on CC/CDC plans & specs | Certifier check |
|---|---|-----------------------|--|--|---------------------|------------------------------|-----------------|
| Windows, glazed doo | ors and skyligh | ts | | | | | |
| | | | evices described in the table below, in a ons must be satisfied for each window a | | ~ | ~ | ~ |
| The dwelling may have 1 s | ~ | ~ | V | | | | |
| The following requirements | ~ | ~ | ~ | | | | |
| For the following glass: | and frame types, the | certifier check can b | e performed by visual inspection. | | | | |
| - Aluminium single cle | ear | | | | | | |
| - Aluminium double (a | air) clear | | | | | | |
| - Timber/uPVC/fibreg | lass single clear | | | | | | |
| - Timber/uPVC/fibreg | lass double (air) cle | ar | | | | | |
| be calculated in accor table below are for ref | dance with National erence only. gs/vegetation must b | Fenestration Rating (| n the range of those listed. Total systen Council (NFRC) conditions. Frame and istance from the centre and the base of | glass types shown in the | | | |
| Window/glazed door no. | Maximum height (mm) | Maximum width | Туре | Shading Device (Dimens | sion within | Overshadowing | |
| North-East facing | neight (mm) | - Lumny | | 1011 | | | |
| W6 | 1200 | 2410 | U-value: 5.6, SHGC: 0.369 - 0.451 (aluminium, single, Lo-Tsol Low-e) | none | | not overshadowed | |
| W7 | 1600 | 800 | aluminium, single, clear | eave 550 mm, 100 mm ab of window or glazed door | ove head | not overshadowed | |
| W8 | 1600 | 800 | aluminium, single, clear | eave 550 mm, 100 mm ab of window or glazed door | ove head | not overshadowed | |
| | 2400 | 4200 | aluminium, single, clear | solid overhang 3600 mm. | | not overshadowed | |

| Energy Commitments | Show on DA plans | Show on CC/CDC plans & specs | Certifier check |
|---|---------------------|------------------------------|--------------------|
| Hot water | | | |
| The applicant must install the following hot water system in the development, or a system with a higher energy rating: gas instantaneous with a performance of 6 stars. | ~ | ~ | ~ |
| Cooling system | | | |
| The applicant must install the following cooling system, or a system with a higher energy rating, in at least 1 living area: 1-phase irrounditioning; Energy rating: EER 3.5 - 4.0 | | ~ | ~ |
| The applicant must install the following cooling system, or a system with a higher energy rating, in at least 1 bedroom: 1-phase irrconditioning; Energy rating: EER 3.5 - 4.0 | | ~ | ~ |
| The cooling system must provide for day/night zoning between living areas and bedrooms. | | ~ | ~ |
| Heating system | | | |
| The applicant must install the following heating system, or a system with a higher energy rating, in at least 1 living area: 1-phase irrounditioning; Energy rating: EER 3.5 - 4.0 | | ~ | ~ |
| The applicant must install the following heating system, or a system with a higher energy rating, in at least 1 bedroom: 1-phase irrconditioning; Energy rating: EER 3.5 - 4.0 | | ~ | ~ |
| The heating system must provide for day/hight zoning between living areas and bedrooms. | | ~ | ~ |
| Ventilation | | | |
| The applicant must install the following exhaust systems in the development: | | | |
| At least 1 Bathroom: individual fan, ducted to façade or roof; Operation control: manual on / timer off | | • | - |
| Kitchen: individual fan, ducted to façade or roof; Operation control: manual switch on/off | | • | - |
| Laundry: individual fan, ducted to façade or roof; Operation control: manual switch on/off | | • | - |
| Artificial lighting | | | |
| The applicant must ensure that the "primary type of artificial lighting" is fluorescent or light emitting diode (LED) lighting in each of the ollowing rooms, and where the word "dedicated" appears, the fittings for those lights must only be capable of accepting fluorescent gift emitting diode (LED) largors: • at least 5 of the bedrooms / study, dedicated | | | |

| Water Commitments | Show on DA plans | Show on CC/CDC plans & specs | Certifie check |
|--|---------------------|------------------------------|----------------|
| Fixtures | | _ | |
| The applicant must install showerheads with a minimum rating of 4 star (> 4.5 but <= 6 L/min plus spray force and/or coverage tests) in all showers in the development. | 1 | ~ | |
| The applicant must install a toilet flushing system with a minimum rating of 4 star in each toilet in the development. | | ~ | ~ |
| The applicant must install taps with a minimum rating of 4 star in the kitchen in the development. | | ~ | |
| The applicant must install basin taps with a minimum rating of 4 star in each bathroom in the development. | | ✓ | |
| Alternative water | | | |
| Rainwater tank | | | |
| The applicant must install a rainwater tank of at least 1500 litres on the site. This rainwater tank must meet, and be installed in accordance with, the requirements of all applicable regulatory authorities. | ~ | ~ | ~ |
| The applicant must configure the rainwater tank to collect rain runoff from at least 150 square metres of the roof area of the development (excluding the area of the roof which drains to any stormwater tank or private dam). | | ~ | ~ |
| The applicant must connect the rainwater tank to: | | | |
| the cold water tap that supplies each clothes washer in the development | | • | - |
| at least one outdoor tap in the development (Note: NSW Health does not recommend that rainwater be used for human consumption in areas with potable water supply.) | | ✓ | - |
| evelopment (excluding the area of the roof which drains to any stormwater tank or private dam). he applicant must connect the rainwater tank to: | | | |
| | | _ | - |

| | height (mm) | (mm) | | Shading Device (Dimension within 10%) | Overshadowing |
|-------------------|-------------|------|---|--|------------------------|
| W18 | 1900 | 2400 | U-value: 5.6, SHGC: 0.369 - 0.451 (aluminium, single, Lo-Tsol Low-e) | eave 550 mm, 520 mm above head of window or glazed door | not overshadowed |
| W19 | 1600 | 800 | aluminium, single, clear | eave 550 mm, 1700 mm above head of window or glazed door | not overshadowed |
| W20 | 1600 | 800 | aluminium, single, clear | eave 550 mm, 1700 mm above head of window or glazed door | not overshadowed |
| W21 | 1800 | 610 | aluminium, single, clear | solid overhang 3050 mm, 240 mm above head of window or glazed door | not overshadowed |
| DR03 | 2400 | 2670 | aluminium, single, clear | solid overhang 3050 mm, 240 mm above head of window or glazed door | not overshadowed |
| South-East facing | | | | | |
| W9 | 1500 | 800 | aluminium, single, clear | eave 550 mm, 570 mm above head of window or glazed door | >4 m high, 2-5 m away |
| W10 | 1500 | 800 | aluminium, single, clear | eave 550 mm, 570 mm above head of window or glazed door | >4 m high, 2-5 m away |
| W11 | 1400 | 2170 | aluminium, single, clear | eave 550 mm, 570 mm above head of window or glazed door | >4 m high, 2-5 m away |
| W12 | 1200 | 1200 | aluminium, single, clear | eave 550 mm, 570 mm above head of window or glazed door | >4 m high, 2-5 m away |
| W13 | 1600 | 610 | aluminium, single, clear | eave 550 mm, 100 mm above head of window or glazed door | >4 m high, 2-5 m away |
| W14 | 1600 | 610 | aluminium, single, clear | eave 550 mm, 100 mm above head of window or glazed door | >4 m high, 2-5 m away |
| W15 | 1600 | 700 | aluminium, single, clear | eave 550 mm, 100 mm above head of window or glazed door | >4 m high, 2-5 m away |
| N22 | 1400 | 2410 | aluminium, single, clear | none | >4 m high, 2-5 m away |
| South-West facing | | | | | |
| W24 | 1950 | 2200 | aluminium, single, clear | eave 550 mm, 100 mm above head of window or glazed door | 2-4 m high, 2-5 m away |
| North-West facing | | | | | |

BASIX REQUIREMENTS

| Energy Commitments | Show on DA plans | Show on CC/CDC plans & specs | Certifier check |
|---|---------------------|------------------------------|-----------------|
| at least 2 of the living / dining rooms; dedicated | | ~ | |
| the kitchen; dedicated | | • | - |
| all bathrooms/toilets; dedicated | | ✓ | - |
| the laundry; dedicated | | • | - |
| all hallways; dedicated | | • | - |
| Natural lighting | | | |
| The applicant must install a window and/or skylight in the kitchen of the dwelling for natural lighting. | | ~ | - |
| The applicant must install a window and/or skylight in 2 bathroom(s)/toilet(s) in the development for natural lighting. | ~ | ~ | - |
| Other | | | |
| The applicant must install a gas cooktop & electric oven in the kitchen of the dwelling. | | ~ | |
| The applicant must construct each refrigerator space in the development so that it is "well ventilated", as defined in the BASIX definitions. | | ~ | |
| The applicant must install a fixed outdoor clothes drying line as part of the development. | | ~ | |
| | | | |

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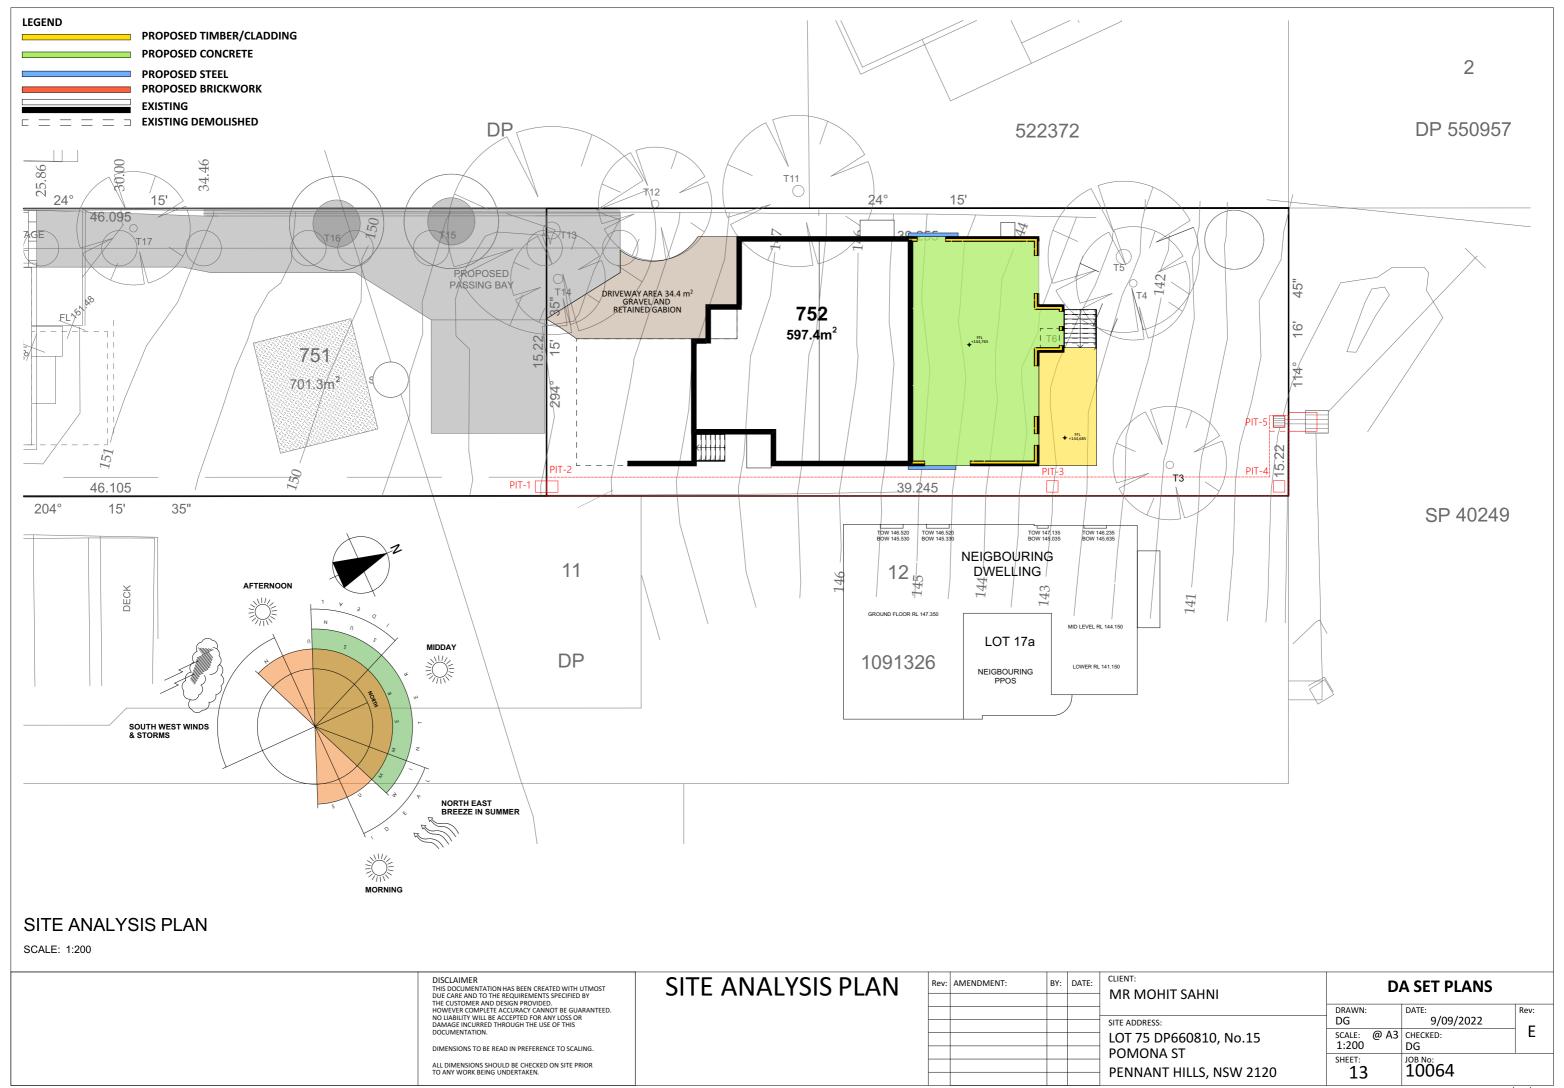
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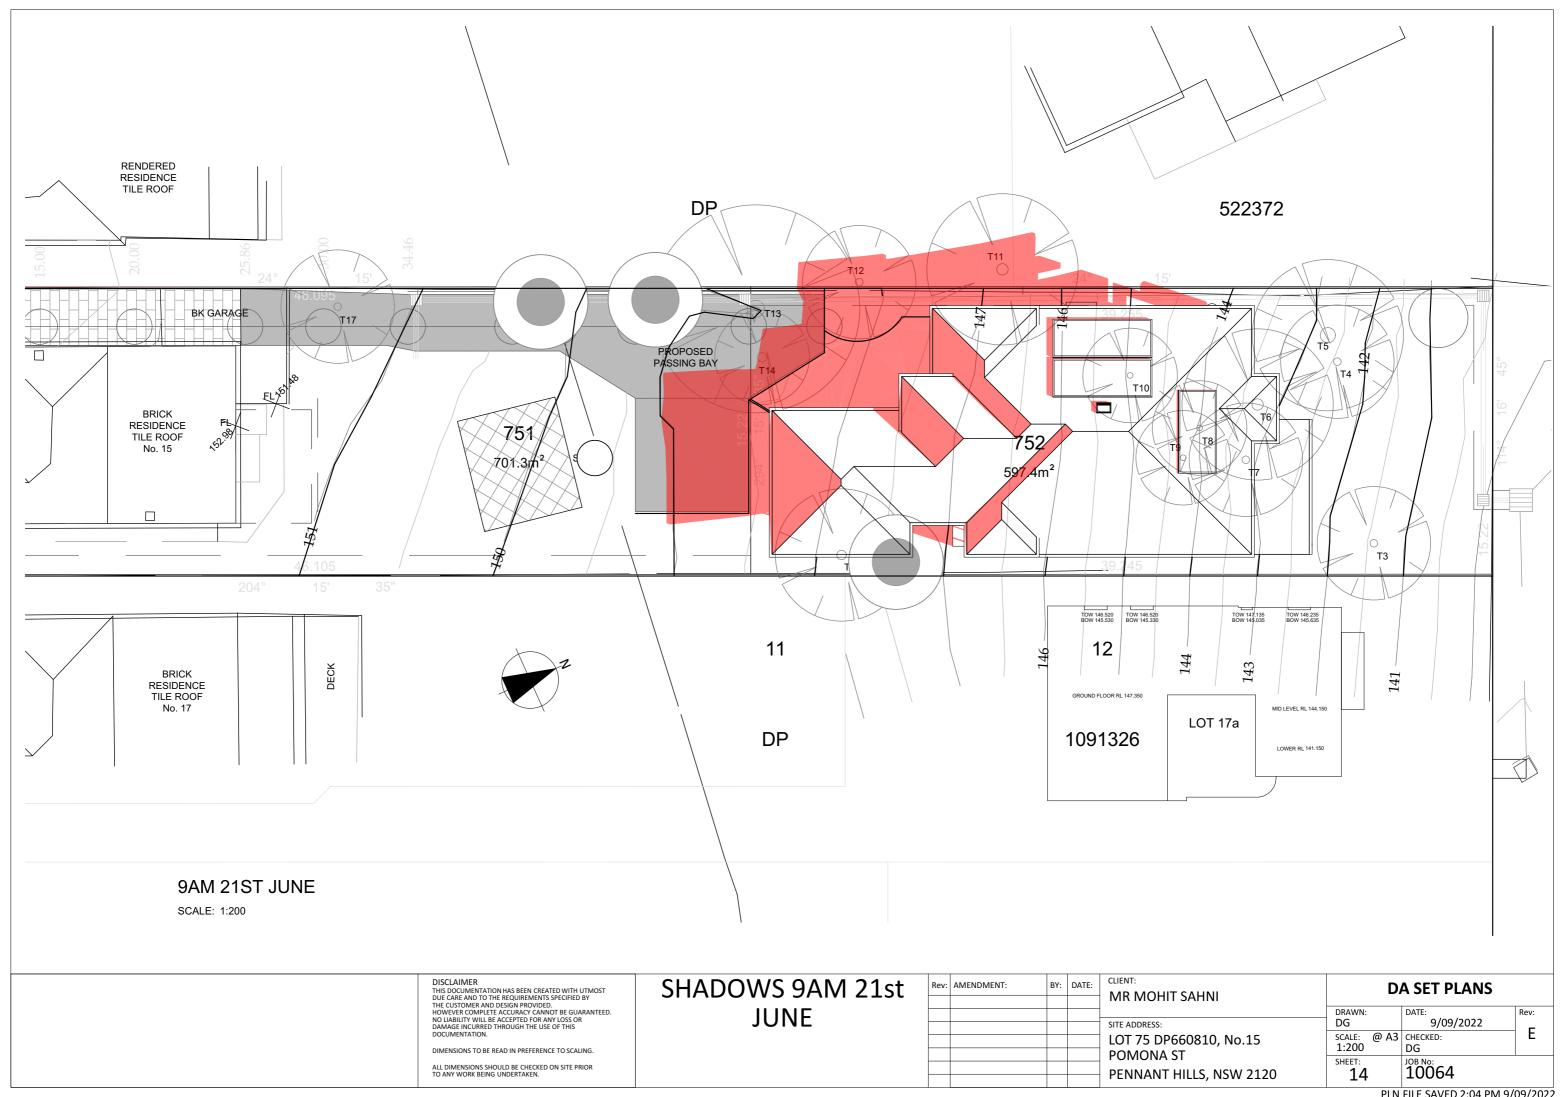
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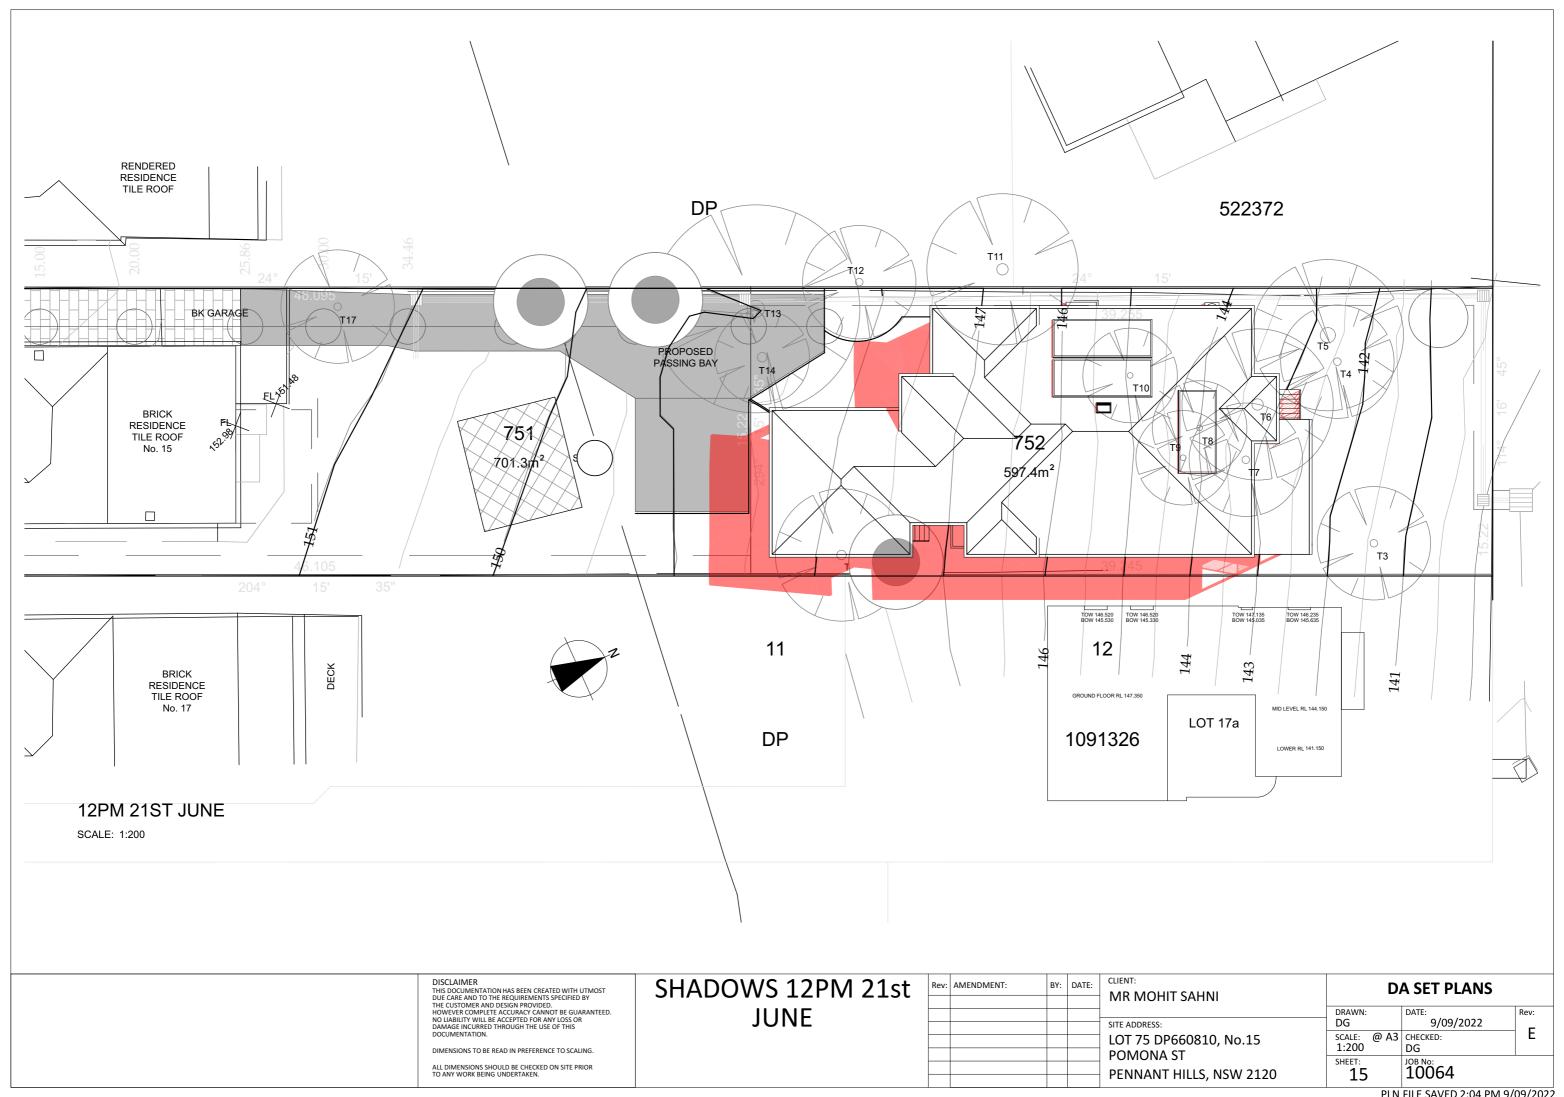
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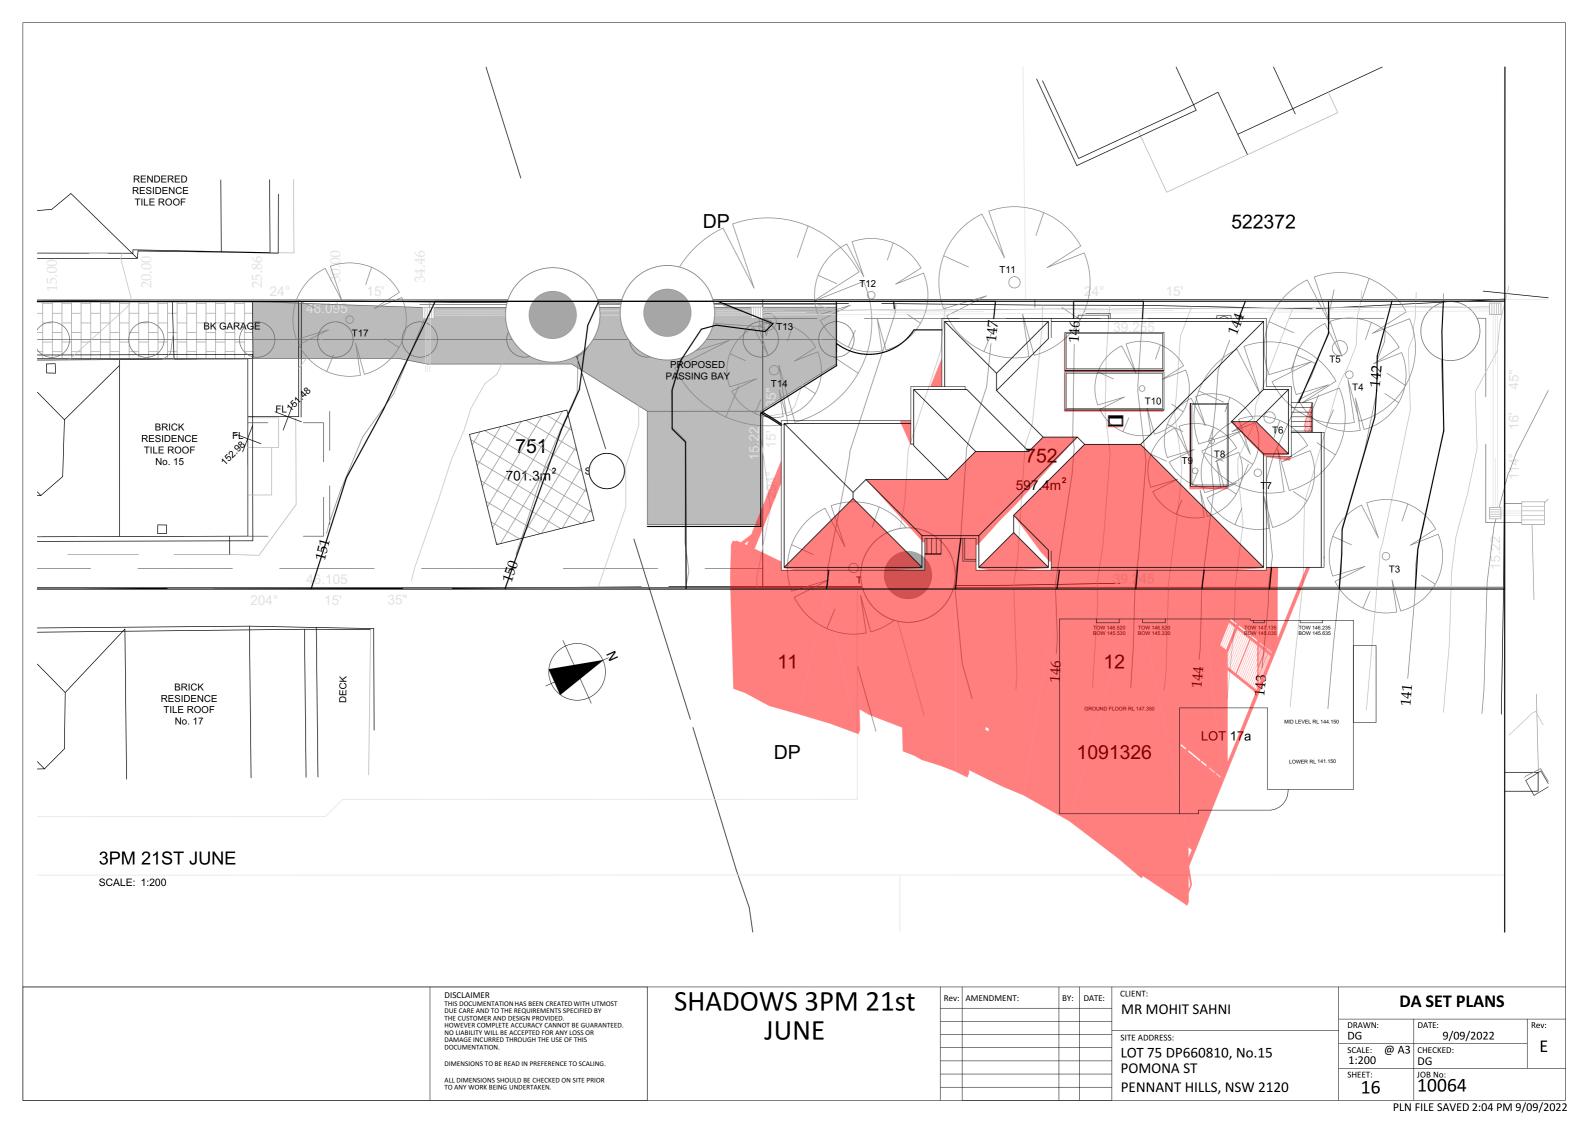
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|------|------------|-----|-------|-------------------------|
| | | | | MR MOHIT SAHNI |
| | | | | SITE ADDRESS: |
| | | | | LOT 75 DP660810, No.15 |
| | | | | POMONA ST |
| | | | | PENNANT HILLS, NSW 2120 |
| | | | | |


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| DRAWN: DG | DATE: 9/09/2022 | Rev: |
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| SHEET: | 10064 | |












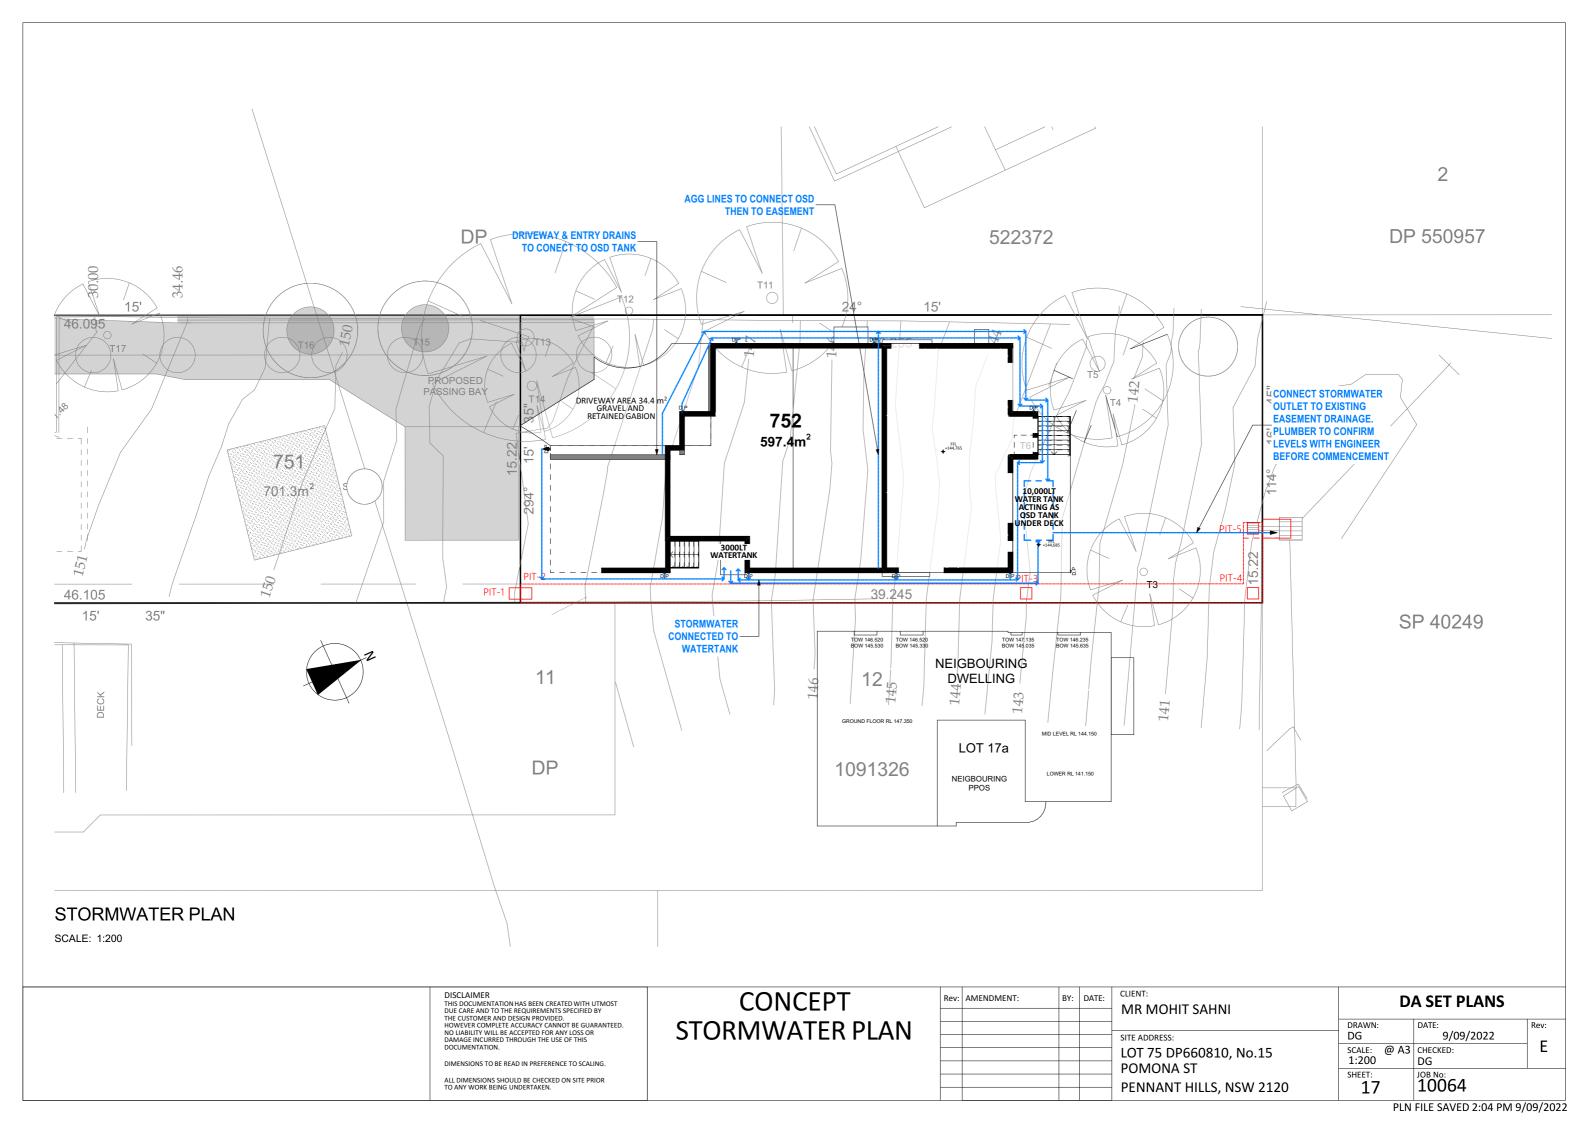

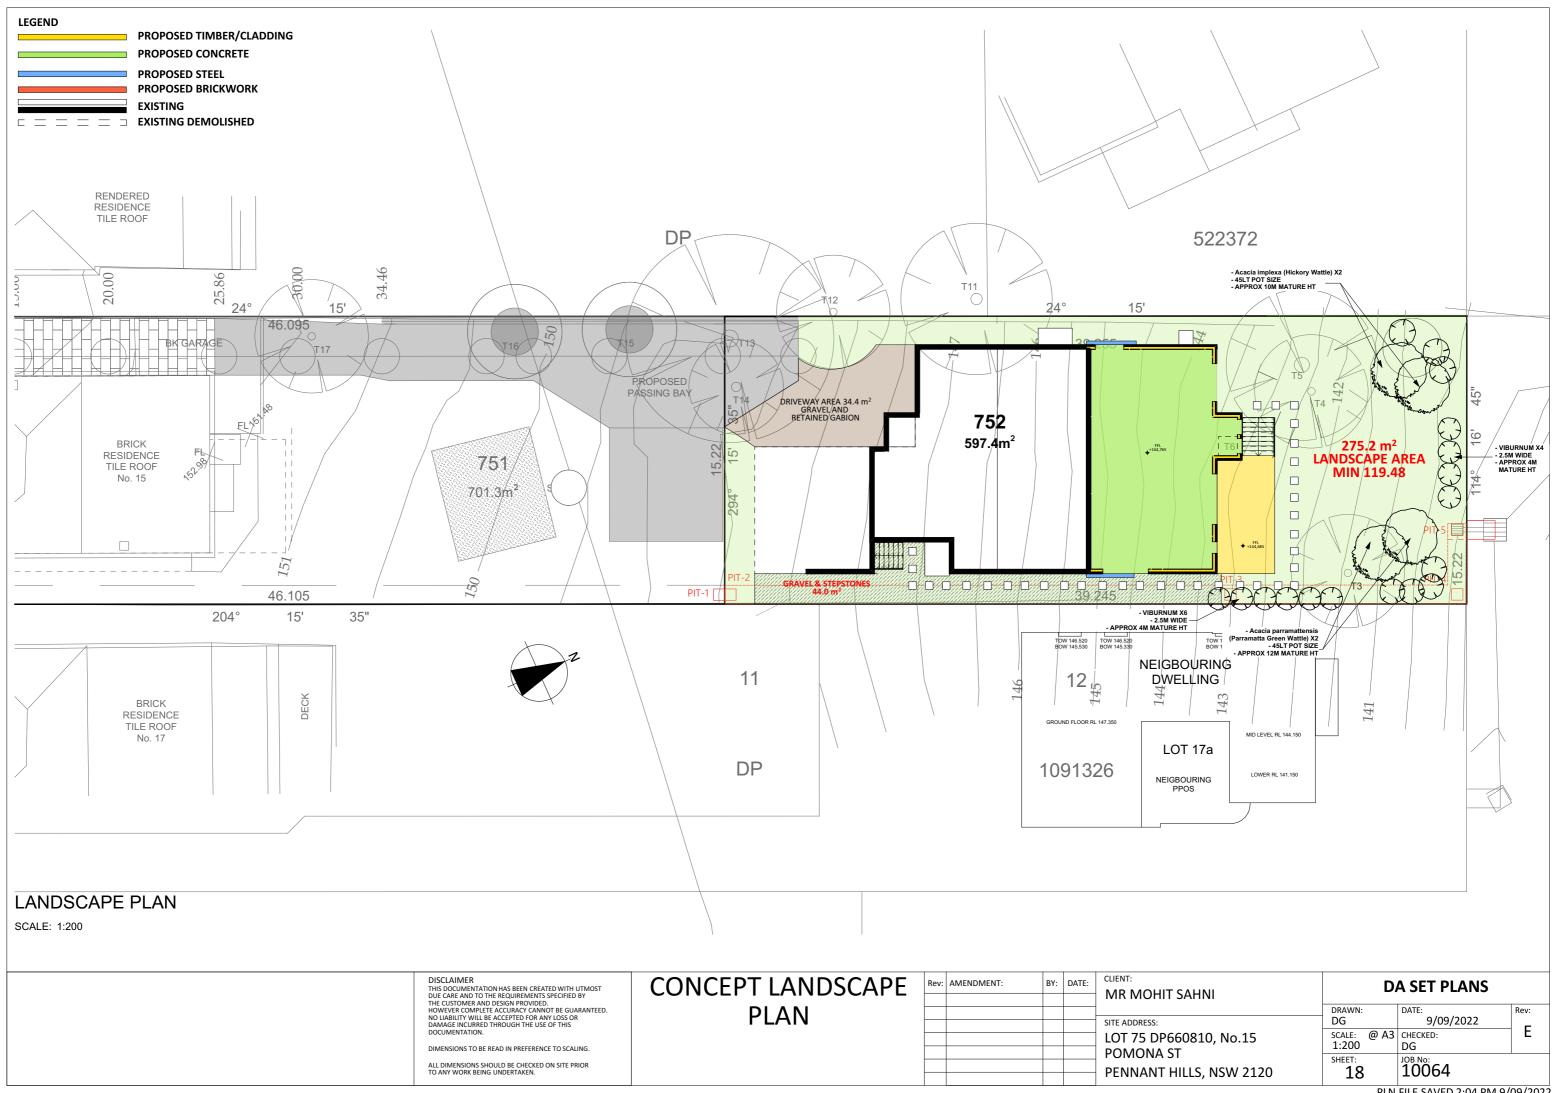

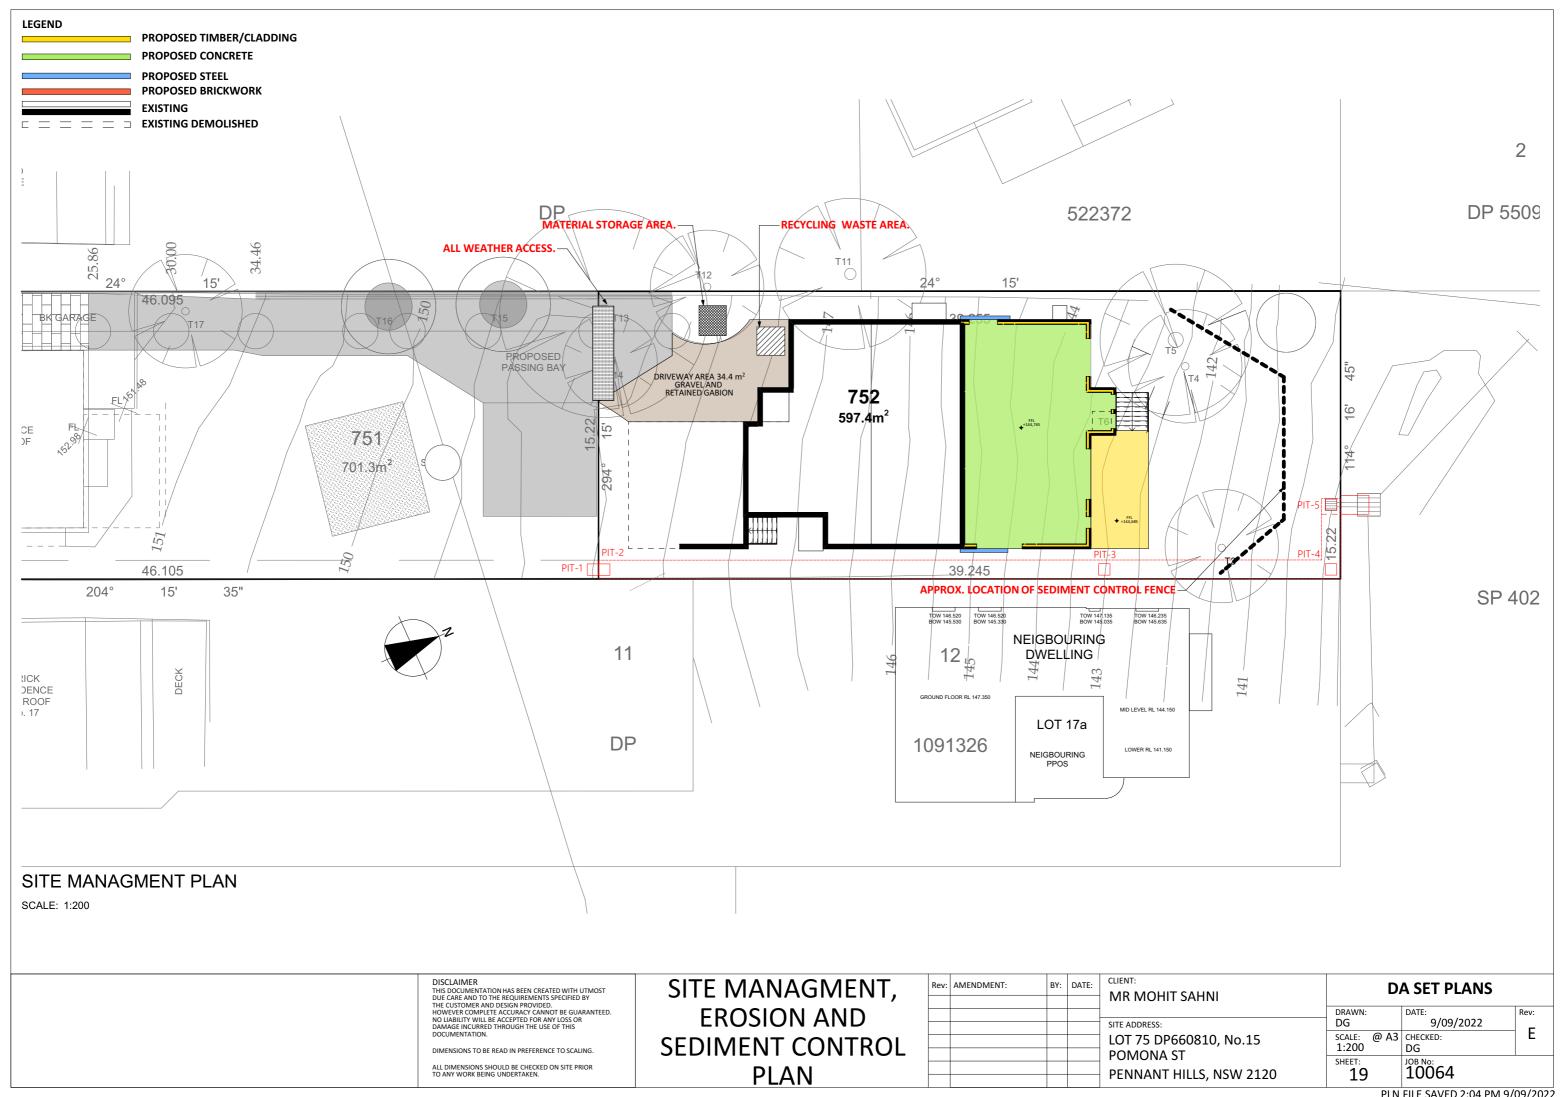

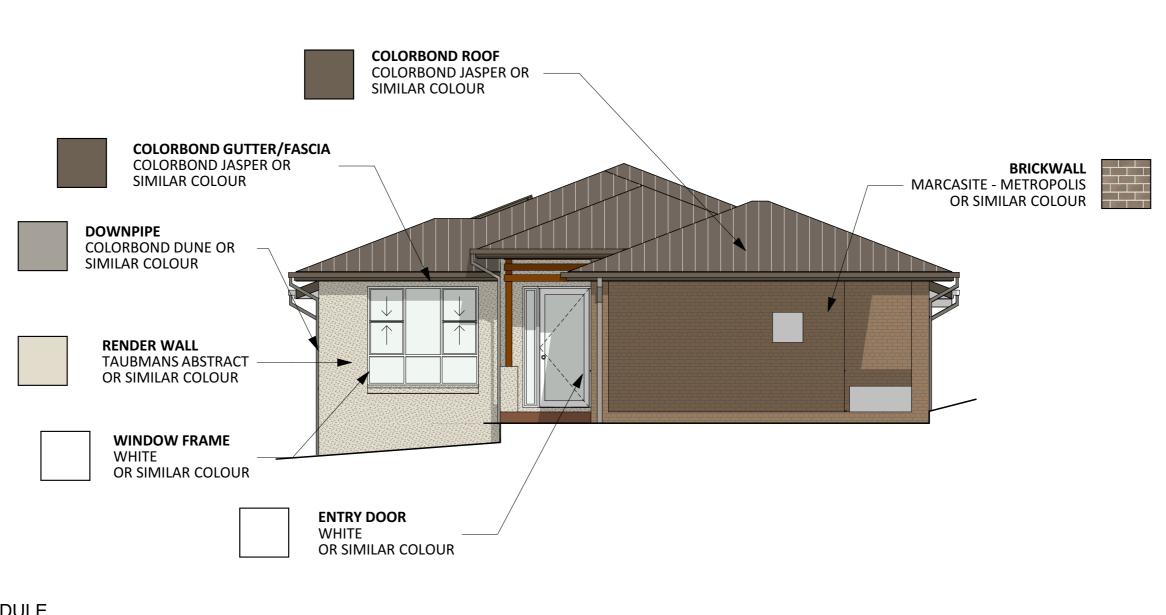

COLOR SCHEDULE

SCALE: 1:75

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DOCUMENTATION.

DIMENSIONS TO BE READ IN PREFERENCE TO SCALING.

ALL DIMENSIONS SHOULD BE CHECKED ON SITE PRIOR TO ANY WORK BEING UNDERTAKEN.

COLOUR SCHEDULE

| Rev: | AMENDMENT: | BY: | DATE: | CLIENT: MR MOHIT SAHNI | DA SET PLANS | | | | |
|------|------------|-----|-------|-------------------------------|--------------|------|-----------------|--|--|
| | | | | SITE ADDRESS: | DRAWN: | | DATE: 9/09/2022 | | |
| | | | | LOT 75 DP660810, No.15 POMONA | | @ A3 | CHECKED: | | |
| | | | | · | | | DG | | |
| | | | | PENNANT HILLS, NSW 2120 | SHEET: | | 10064 | | |

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